

#### **CONSTRUCTION NOTES:**

- A. FENCES SHALL BE USED IN AREAS WHERE EROSION WILL OCCUR ONLY IN THE FORM OF SHEET EROSION AND THERE IS NO CONCENTRATION OF WATER IN A CHANNEL OR OTHER DRAINAGE WAY ABOVE THE FENCE;
- THE MAXIMUM CONTRIBUTING DRAINAGE AREA ABOVE THE FENCE SHALL BE LESS THAN 1/4-ACRE PER 100 LINEAR FEET OF
- THE MAXIMUM LENGTH OF THE SLOPE ABOVE THE FENCE SHALL BE 100 FEET;
  THE MAXIMUM SLOPE OF THE AREA ABOVE THE FENCE SHALL BE 2:1;
  FENCES SHALL BE INSTALLED AS FOLLOWS:

  1. FENCES SHALL FOLLOW THE CONTOUR OF THE LAND AS CLOSELY AS POSSIBLE;

- 2. THE ENDS OF THE FENCE SHALL BE FLARED UP-SLOPE;

  3. THE BASE OF THE FENCE SHALL BE:

  a. FOLDED SUCH THAT NOT LESS THAN 4 INCHES OF THE FENCE IS PLACED ALONG THE BOTTOM OF A TRENCH THAT IS EXCAVATED AT LEAST 4 INCHES DEEP INTO THE GROUND, WITH THE SOIL COMPACTED OVER THE EMBEDDED FABRIC; OR b. IF SITE CONDITIONS INCLUDE FROZEN GROUND, LEDGE, OR THE PRESENCE OF HEAVY ROOTS, EMBEDDED IN A MINIMUM THICKNESS OF 8 INCHES OF 3/ INCHES
- THICKNESS OF 8 INCHES OF 34 -INCH STONE;


- THICKNESS OF 8 INCHES OF % —INCH STONE;

  4. SUPPORT POSTS SHALL BE SIZED AND ANCHORED ACCORDING TO THE MANUFACTURER'S INSTRUCTIONS; AND


  5. ADJOINING SECTIONS OF THE FENCE SHALL BE OVERLAPPED BY 6 INCHES, FOLDED AND STAPLED TO A SUPPORT POST;
  FENCES SHALL BE INSPECTED AND MAINTAINED IMMEDIATELY AFTER EACH RAINFALL AND AT LEAST DAILY DURING PROLONGED
  RAINFALL, ANY REPAIRS THAT ARE REQUIRED SHALL BE MADE IMMEDIATELY; AND
  SEDIMENT THAT ACCUMULATES AT THE FENCE SHALL BE REMOVED WITH SUFFICIENT FREQUENCY TO PREVENT THE DEPTH OF THE
  SEDIMENT FROM REACHING ONE—THIRD THE HEIGHT OF THE FENCE.
  INSTALL FENCE PER MANUFACTURES SPECIFICATIONS.
  IF THE FABRIC ON THE SILT FENCE SHOULD DECOMPOSE OR BECOME INEFFECTIVE DURING THE LIFE OF THE FENCE, THE FABRIC
  SHALL BE PROMPTLY REPLACED.
- SHALL BE PROMPILI REPLACED.

  SEDIMENT DEPOSITS THAT ARE REMOVED OR LEFT IN PLACE AFTER THE BARRIER HAS BEEN DISMANTLED SHALL BE GRADED TO CONFORM WITH THE EXISTING TOPOGRAPHY AND VEGETATED USING THE APPROPRIATE VEGETATIVE BMP.

## SILT FENCE DETAIL

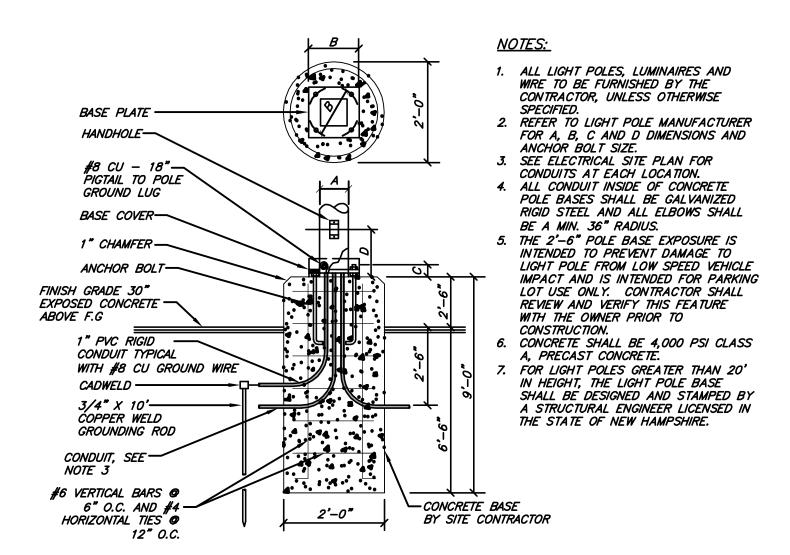


LIGHT POLE BASE DETAIL NOT TO SCALE

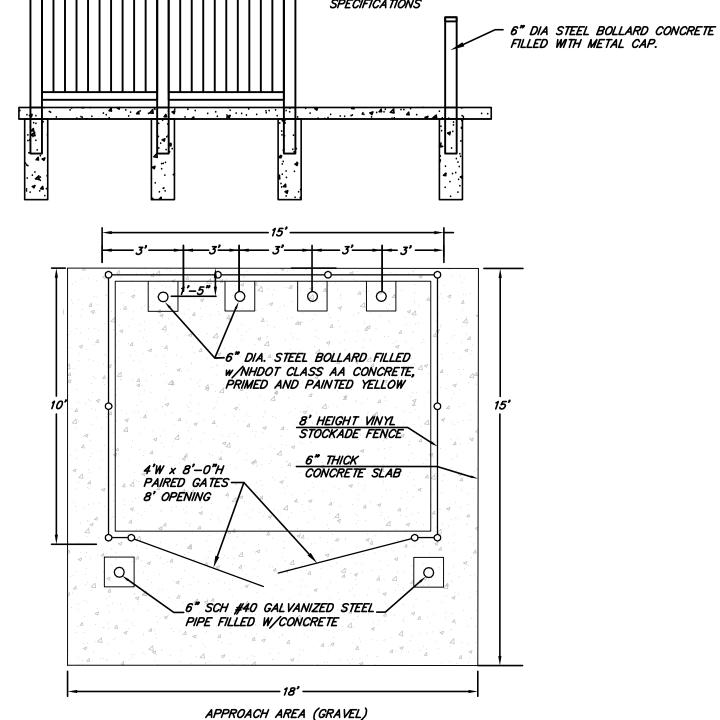

8'-0" HIGH VINYL PRIVACY FENCING

INSTALLED AS PER MANUFACTURES

**DUMPSTER ENCLOSURE DETAIL** 

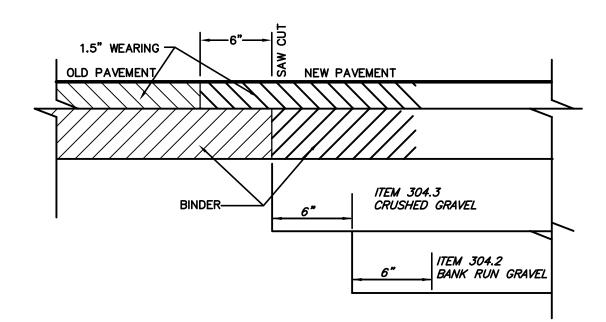


# PROPOSED DRIVEWAY SECTION EXISTING N.H. RTE 101 3" ITEM 403.11 HOT — BITUMINOUS PAVEMENT 1" WEARING COURSE SECTION 1-1/2" WEARING COURSE 2" BINDER COURSE -2" BINDER COURSE

NEW TO OLD PAVEMENT DETAIL

PAVEMENT SECTION TRANSITION N.H. ROUTE 101/ ENTRANCE DRIVE

ROUTE 101. TRANSITION FROM N.H. ROUTE 101 TO BE PROVIDED

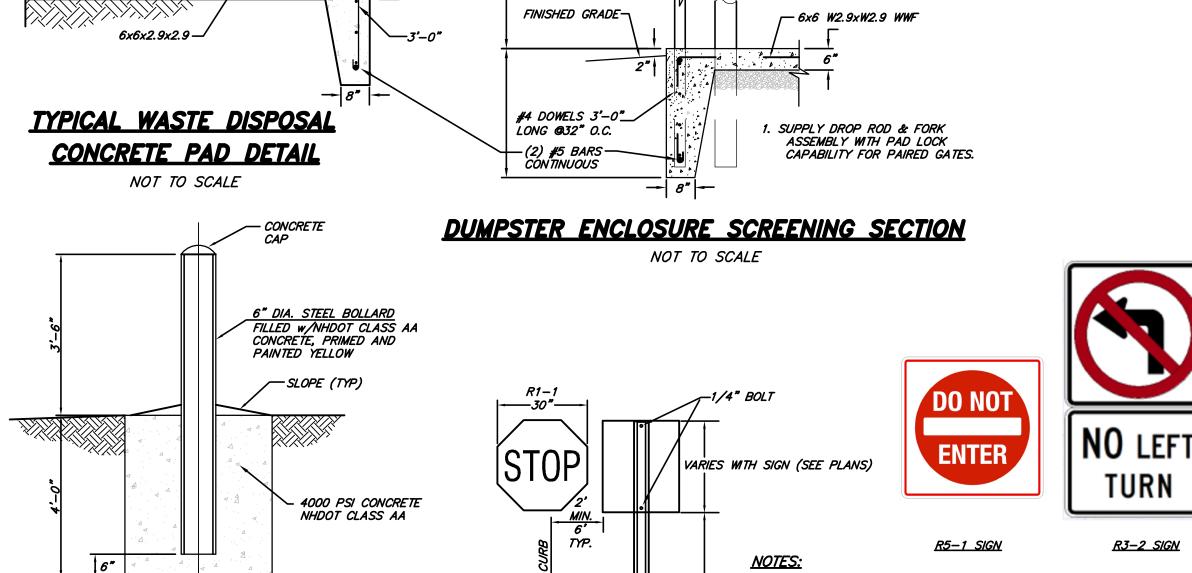


### TYPICAL BOLLARD DETAIL FOR DUMPSTER PAD NOT TO SCALE

- 4000 PSI CONCRETE

NHDOT CLASS AA

COVER

GROUND-5. SIGNS SHALL BE ERECTED IN CONFORMANCE WITH THE REQUIREMENTS

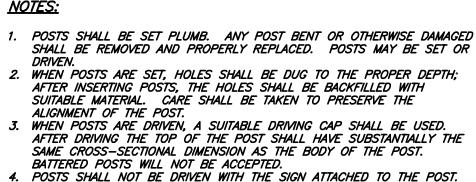

OF THE "MANUAL ON UNIFORM TRAFFIC CONTROL DEVICES, LATEST 6. WHEN THE SIGN IS IN PLACE NO PART OF THE POST SHALL BE VISIBLE


# TRAFFIC SIGN DETAIL

8'-0" HIGH VINYL PRIVACY FENCING INSTALLED AS PER MANUFACTURES

6" DIA STEEL BOLLARD

SEE DETAIL THIS SHT.

NOT TO SCALE

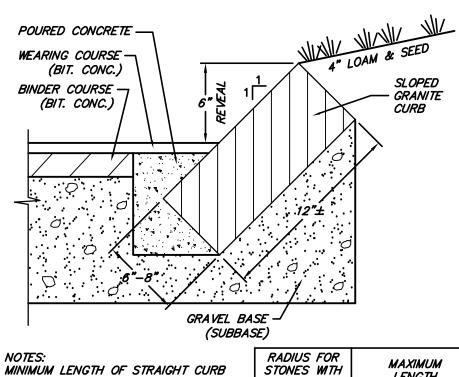

(SUBBASE)			
NOTES: MINIMUM LENGTH OF STRAIGHT CURB STONES = 1'	RADIUS FOR STONES WITH SQUARE JOINTS	MAXIMUM LENGTH	
	< 2	USE CURVED CURB	
MAXIMUM LENGTH OF STRAIGHT CURB	2 - 15	USE RADIAL JOINTS	
STONES = 8'	16 - 28	1′-6″	
AND THE RESERVE OF CTRAINING CURR	29 - 41	2'	
MINIMUM LENGTH OF STRAIGHT CURB STONES LAID ON CURVE = SEE	42 - 55	<i>3</i> ′	
CHART	<i>56 - 68</i>	4'	
	69 - 82	<i>5</i> ′	
ADJOINING STONES SHALL HAVE THE	83 - 96	<i>6'</i>	
SAME OR APPROXIMATELY THE SAME LENGTH	97 - 110	7'	
	OVER 110	<i>8'</i>	

TURN ARROW (RIGHT TURN OPPOSITE IN KIND)

SLOPED GRANITE CURB DETAIL

Owner / Applicant: CONLEY ENTERPRISES, INC 120 JUNIPER HILL ROAD GILFORD, NH 03249

CONSTRUCTION DETAILS SITE PLAN AMENDMENT FOR 1004 LACONIA ROAD TAX MAP 24, LOTS 23, 24, 25 BAY ROAD AND LACONIA ROAD SANBORNTON, NH

	REVISIONS		
DATE	DESCRIPTION	DWN BY	CK BY

Rokeh Consulting, LLC 89 KING ROAD, CHICHESTER, NH PH: 603-387-8688

SCALE: AS NOTED DATE: APRIL 8, 2024 DR. BY: JR CK. BY: JR JOB NO. \_\_\_\_\_ SHEET NO. 2 OF 2